


PLANT LIST				
BOTANICAL NAME	COMMON NAME	CALIPER	HEIGHT	QUANTITY
STREETSCAPE				
Quercus laurifolia	Swamp Laurel Oak	2	8'	7
Ilex decidua	Possum Haw	4	8'	4
PARKING SCREENING				
Quercus laurifolia	Swamp Laurel Oak	2 1/2"	8'	4
Ilex cornuta 'Burfordii'	Burford Holly		8'	3
Leucothoe populifolia	Florida Leucothoe		24"	26
Ilex cornuta 'Needlepoint'	Needlepoint Holly		24"	32
CANOPY TREES WITHIN 60' OF PARKING SPACE				
Quercus phellos	Willow Oak	2 1/2"	8'	5
Quercus laurifolia	Swamp Laurel Oak	2 1/2"	8'	4
Quercus lyrata	Overcup Oak	2 1/2"	8'	6
Pistachia chinensis	Chinese Pistache	2 1/2"	8'	3
SCREENING				
Myrica cerifera	Wax Myrtle		24"	120
Pinus taeda	Loblolly Pine	2"	8'	3
FOUNDATION PLANTING				
Amelanchier alnifolia	Autumn Brilliance Serviceberry		8"	2
Lagerstroemia x 'Muskogee'	Muskogee Crape Myrtle		8"	11
Ilex x 'Nellie R. Stevens'	Nellie Stevens Holly		6"	3
Ilex vomitoria 'Nana'	Dwarf Yaupon Holly		15"	88
Spiraea bumalda 'Anthony Waterer'	Anthony Waterer Spiraea		15"	12

NOTES:
 1. Water well immediately after planting, even if it is raining. Monitor moisture in rootball w/ soil probe throughout the establishment period.
 2. Trees to be staked and guyed will be determined on site. Stake and guy per details and specifications.

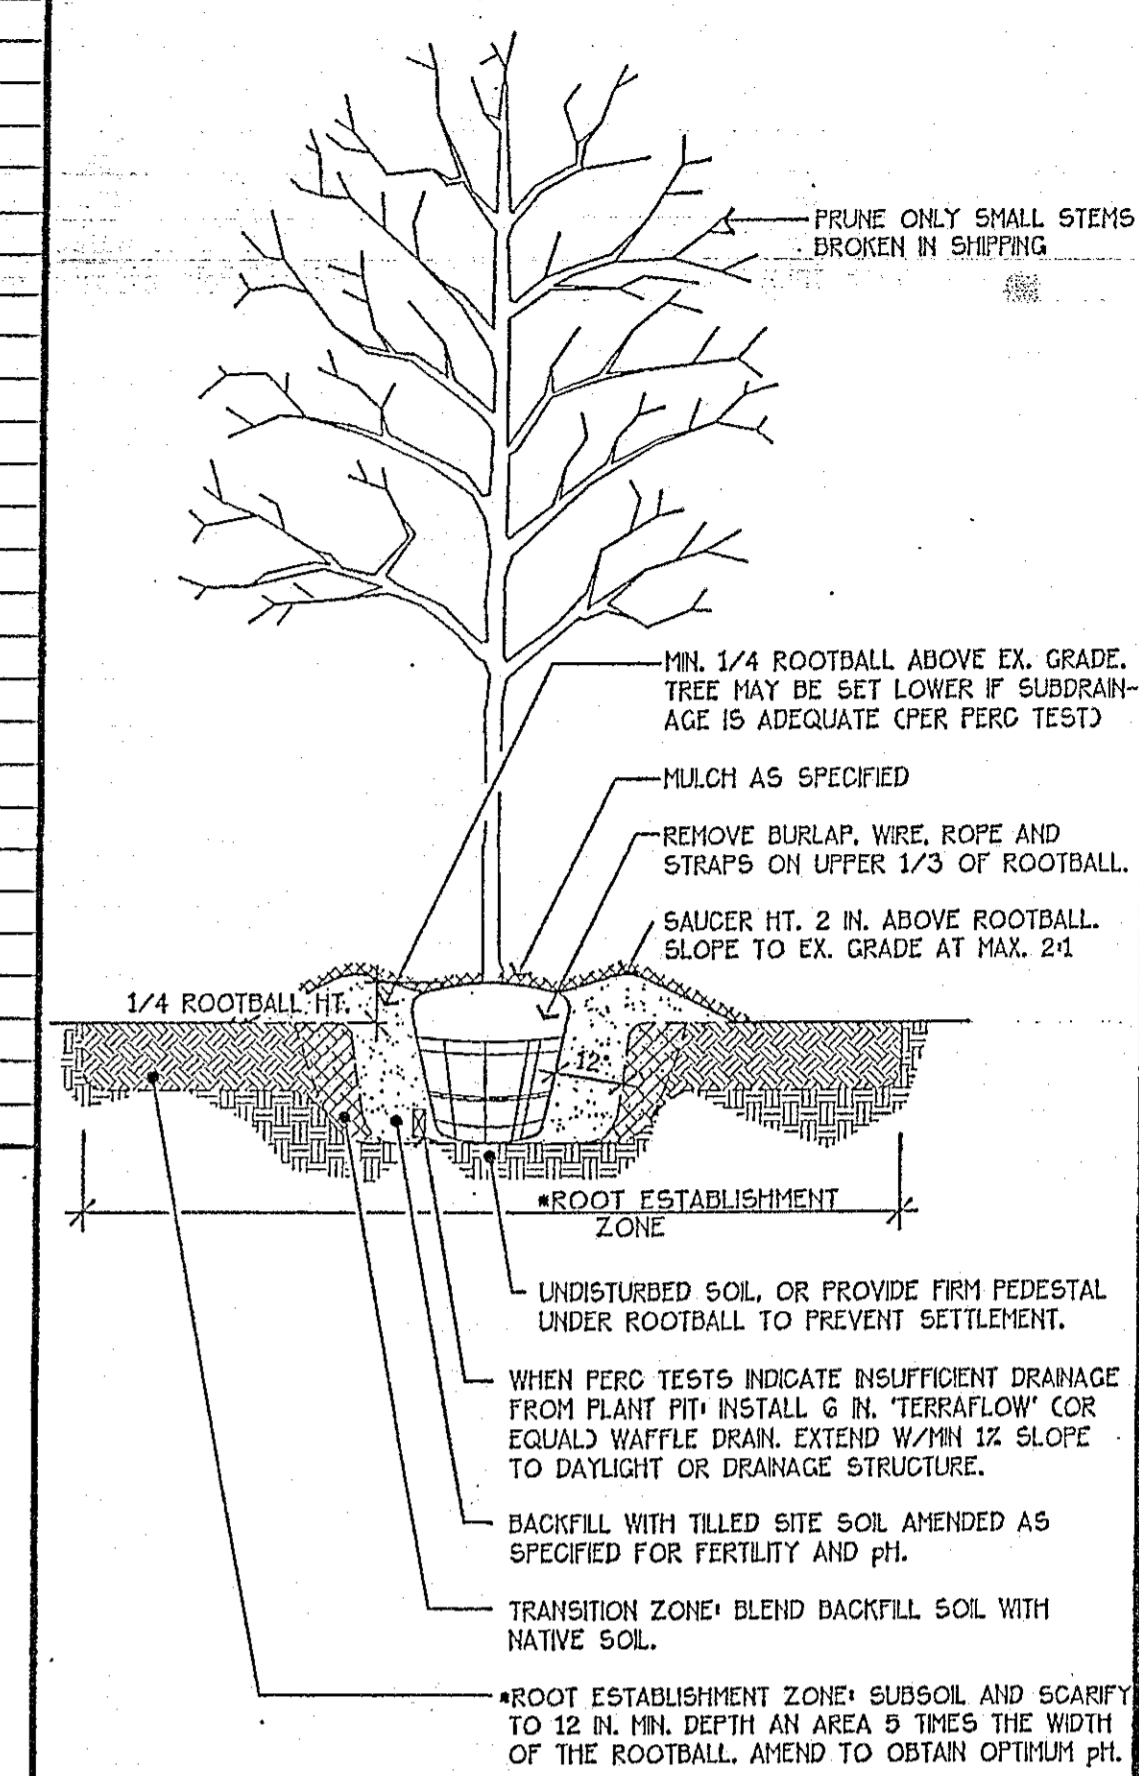

Plant Notes:

- The site is wooded with vegetation typical to the region. Major species include Loblolly Pine and numerous Oak varieties. The road frontage is mostly young Loblolly Pine, 1-2" caliper, very densely spaced. The density of vegetation varies across the site, but the majority of the site can be characterized as heavily to moderately wooded. The sanitary sewer easement is mostly cleared.
- Proposed plantings will not interfere with utilities or site triangles.
- HVAC units are roof-mounted and screened by parapet structures.
- Varieties of plants may change due to availability at time of planting. In the event of changes, the intent of the appearance ordinance shall be met.
- See sheet C05A for details and additional information.
- Do not plant trees within 6 feet of paved surface.


Landscape Maintenance Plan

The owners of the property and their agents, heirs, or assignees shall be responsible for the installation, preservation, and maintenance of all plantings and physical features shown on the plan. The owners shall be responsible for the ongoing landscape management of the vegetation to include but not be limited to:


- Lawn Fertilization: Fertilize lawn areas in early September and mid February according to soils tests.
- pH adjustment: Adjust pH per soil test results in December or January.
- Pruning: Prune newly planted material to remove dead wood, to remove crossed branches or other poor growth habits, to provide for safety issues (site distance, pedestrian safety), to improve appearance, or for hedging. Prune existing trees only as required for health and safety.
- Pest Control: Integrated Pest Management shall be practiced. Use insecticides and fungicides only as necessary for control of specific problems. All distribution of controlled materials to be performed by a person holding appropriate license in the state of North Carolina.
- Weed Control: Integrated Pest Management shall be practiced. Use herbicides only as necessary for control of specific problems. All distribution of controlled materials to be performed by a person holding appropriate license in the state of North Carolina.
- Mulching: Plants will be mulched with 2" of organic mulch. Mulch will be replenished yearly.
- Lawn Mowing: Class A Fescue Turfgrass areas will be mowed weekly during the growing season to a height of 3-3.5". Class B Fescue Turfgrass areas will be mowed every 2 weeks during the growing season.
- Plant Protection: Plantings will be protected from mechanical damage. Protect root zone areas of trees by limiting vehicular traffic in root zones. Insure that mowers and weed-eaters do not damage trees and shrubs. Required plantings will be replaced if damaged or in the event of their death.

Tree Planting (Poorly Drained Soil) NOT TO SCALE

Container plants w/ heavy root mass and few roots circling the root mass: Plant "Dere Root" style. Manually pull root mass apart and spread roots evenly on a firm cone of soil in the base of the plant pit. Do not cut into the root mass. Backfill by hand as specified, insuring that no air pockets remain within the fibrous root mass.

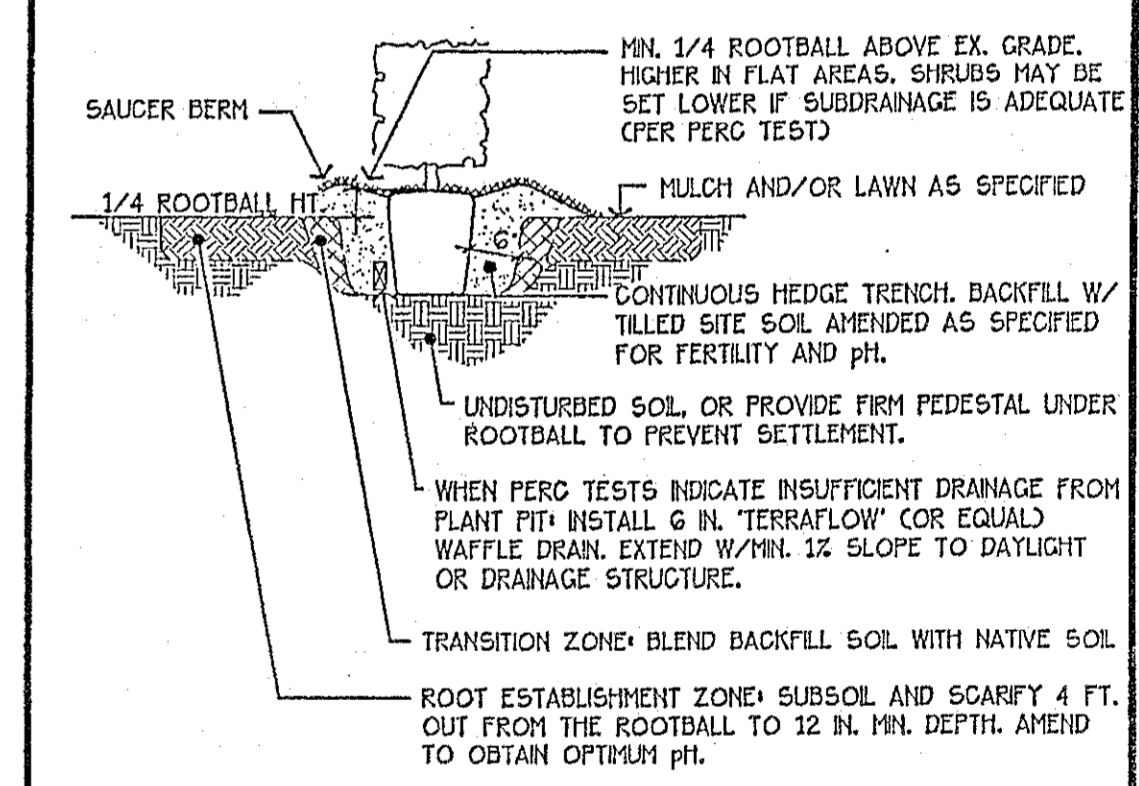


Hedge Planting (Poorly Drained Soil) NTS

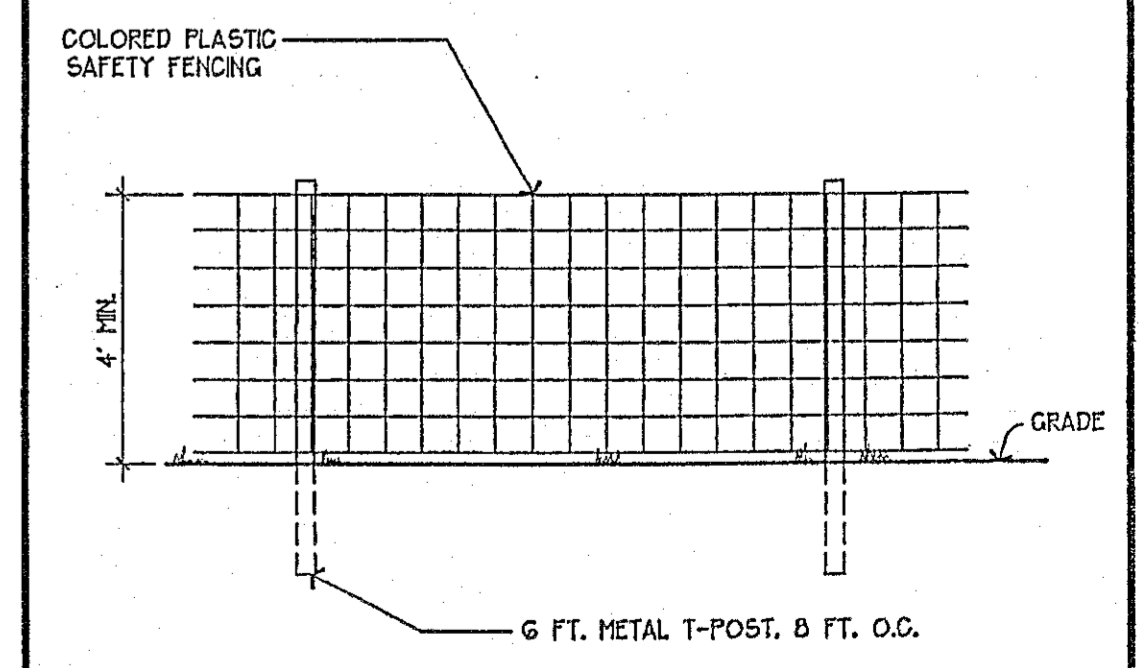

Tree Protection Fence 3/8"x1'-0"

00-SP-233
 APPROVED
 BY: [Signature] DATE: 4/6/01
 BY: TM DATE: 4-9-01
 TOWN OF CARY
 DEVELOPMENT REVIEW GROUP

#	REVISION	DATE	OWNER:
22	January 2001: Re-Submittal Town of Cary		JIM SCHAAFMA C/O CRAIG DAVIS PROPERTIES 3605 GLENWOOD AVENUE SUITE 435 RALEIGH, N.C. 27609 CLIENT: CRAIG DAVIS PROPERTIES 3605 GLENWOOD AVENUE

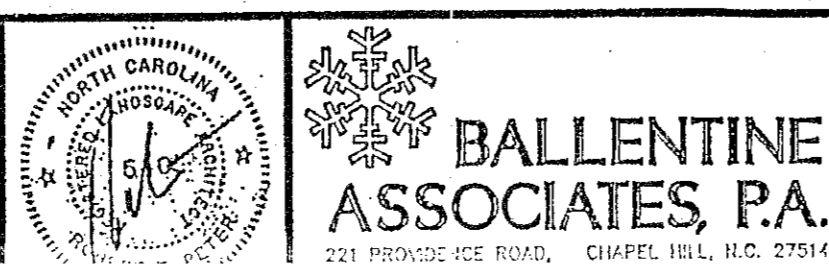

SUBMITTAL	DATE

PLANTING PLAN

SCALE: 1" = 30'
 DATE: 11/30/00
 JOB #: Page1.01
 DRAWN BY: J.T.S.

PAGE PLAZA
 OFFICE BUILDING
 RALEIGH, NORTH CAROLINA

SHEET #:
 CD5A