




1 TRASH COMPACTOR AND RECYCLING AREA LAYOUT PLAN (SCALE: 1" = 10')

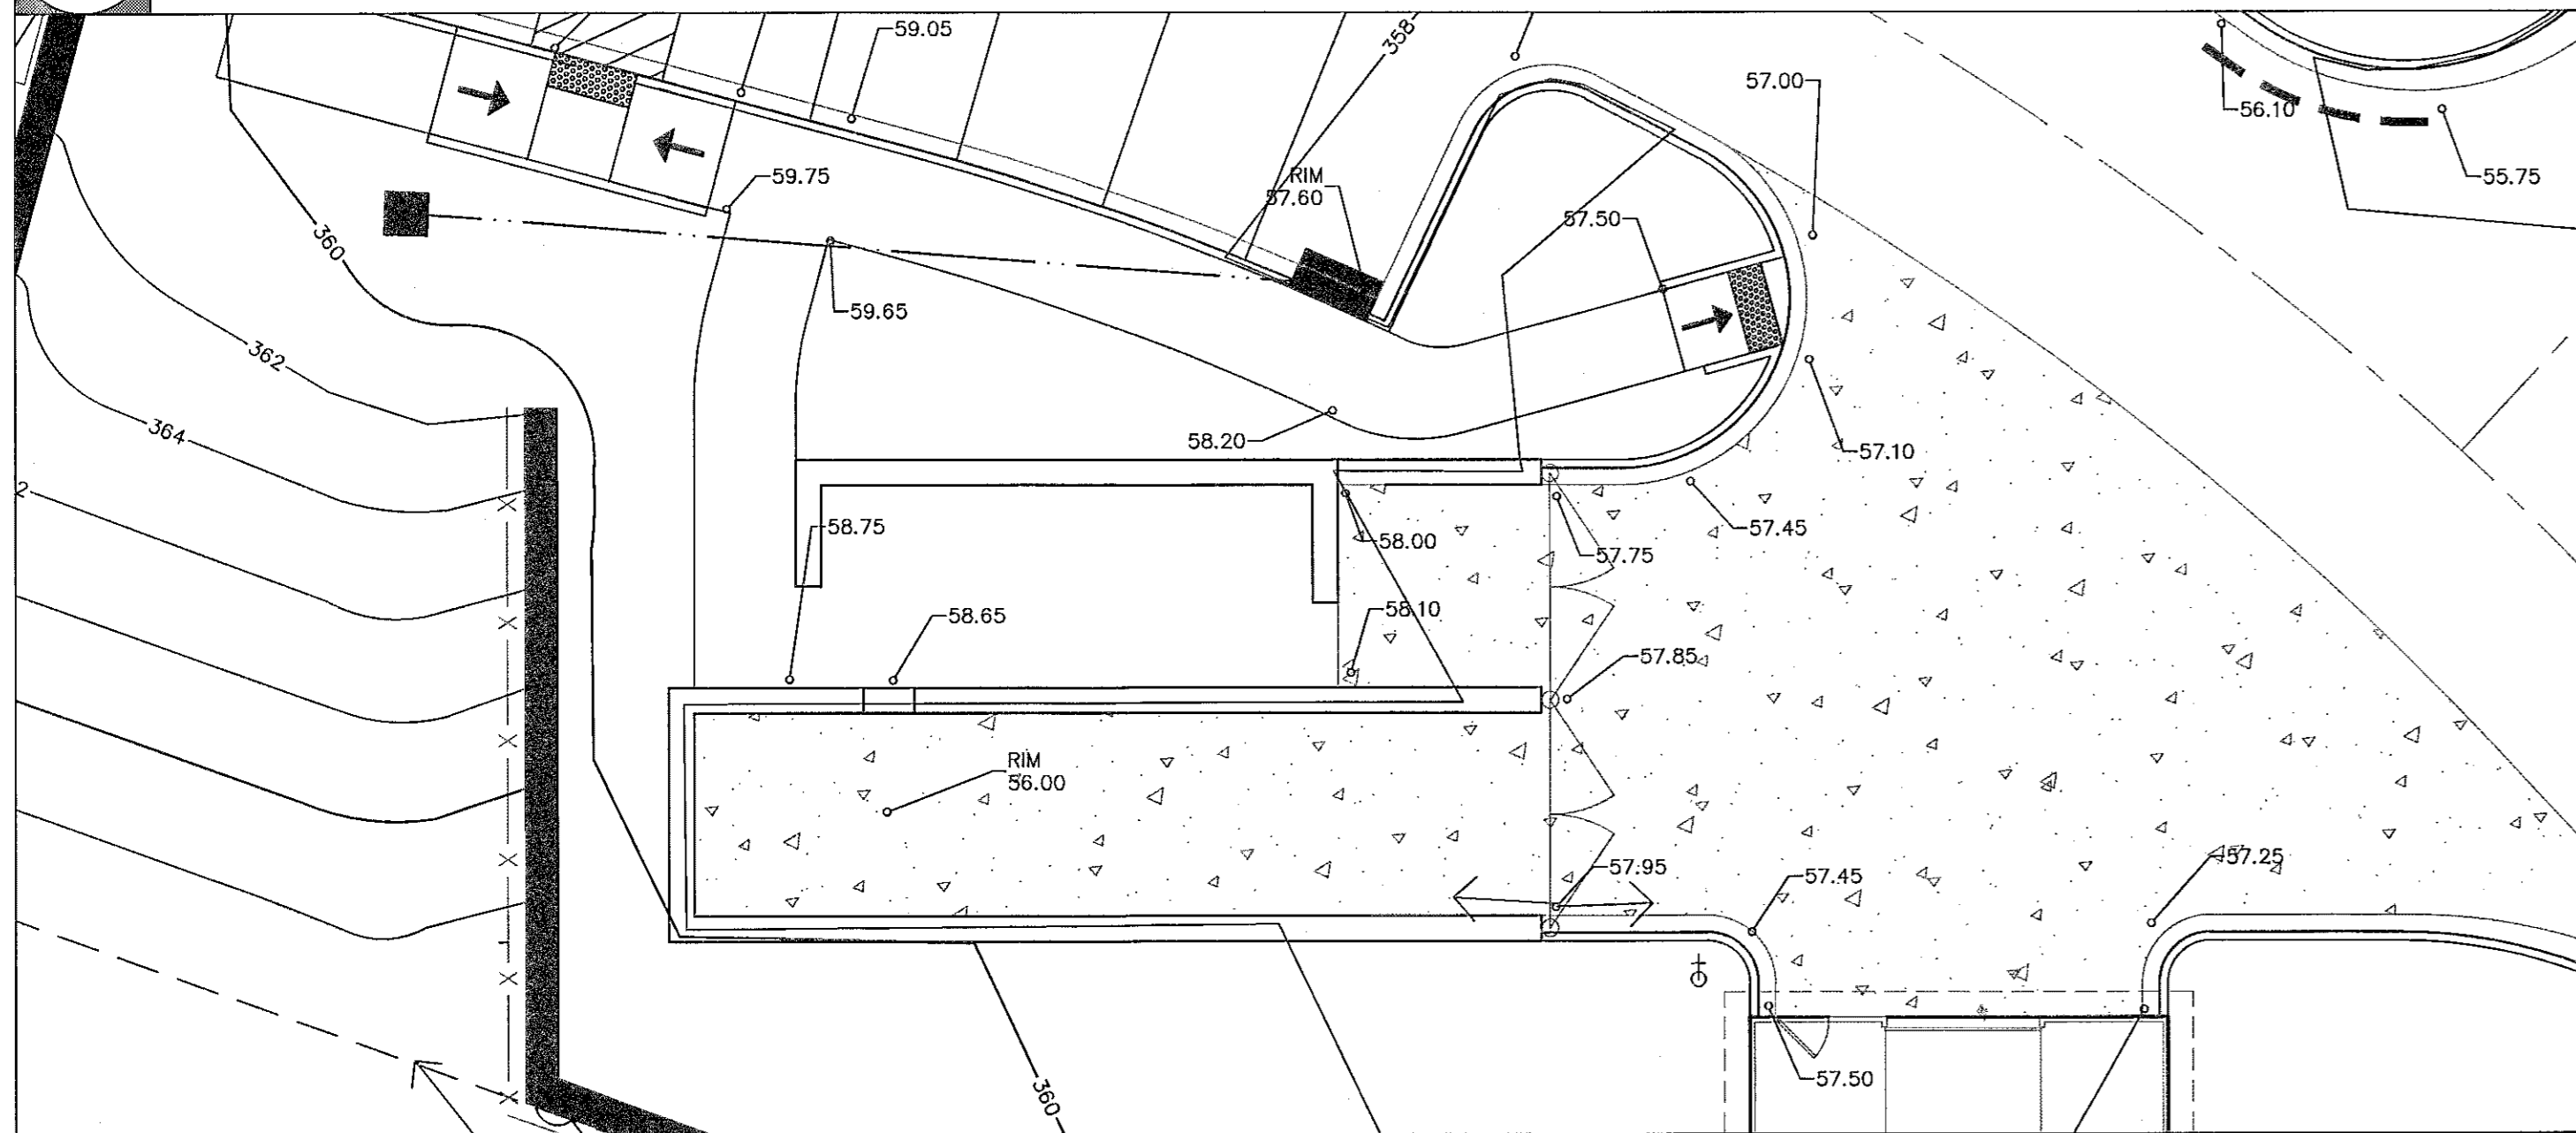


2 TRASH COMPACTOR AND RECYCLING AREA GRADING PLAN (SCALE: 1" = 10')

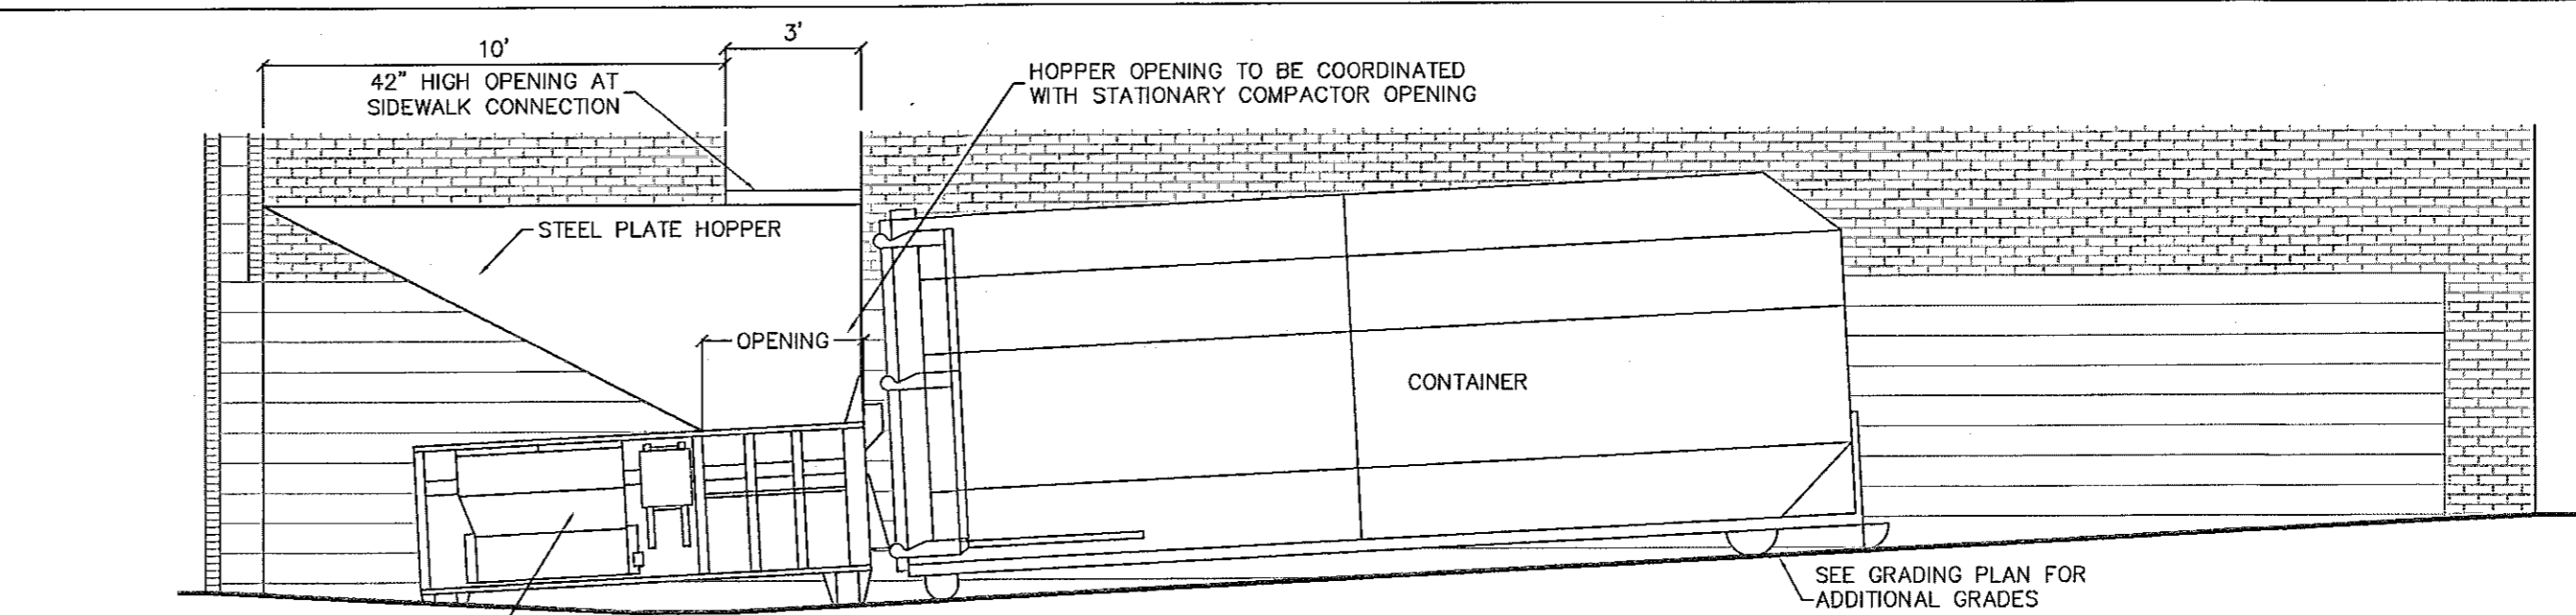

SIDE VIEW

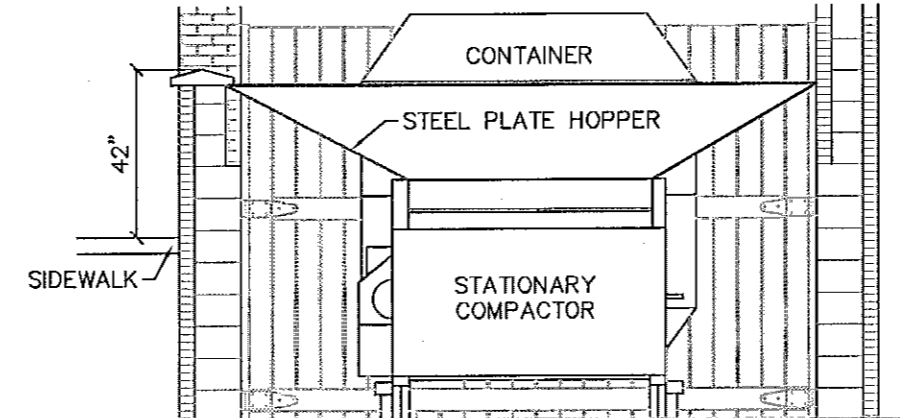


REAR VIEW

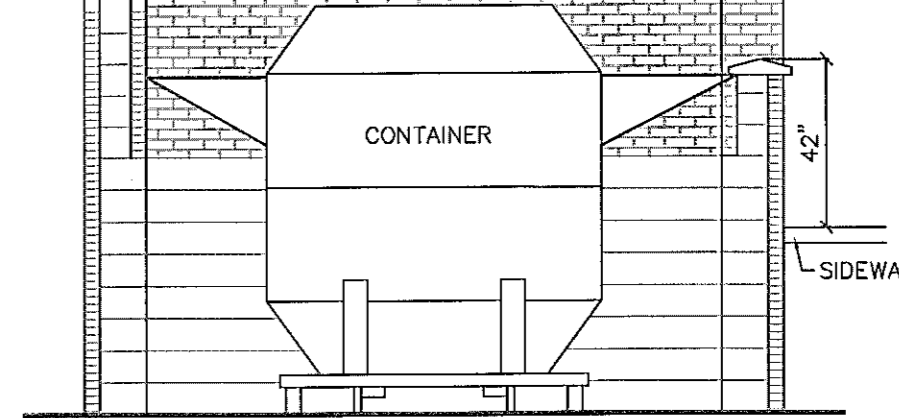

FRONT VIEW


- NOTE:
1. STEEL PLATE HOPPER TO BE CONSTRUCTED AND ATTACHED SO THAT IT REMAINS ON SITE DURING TRASH REMOVAL.
 2. DO NOT ATTACH HOPPER DIRECTLY TO MASONRY WALL.
 3. HOPPER HEIGHT TO BE A MINIMUM OF 54" (4'-6") ABOVE BASE GRADE, PREFERABLY BETWEEN 7' & 8'.
 4. SEE CIVIL DRAWINGS FOR STORM DRAINAGE (OR SANITARY CONNECTION) AS REQUIRED BY LOCAL CODES.
 5. SEE CIVIL ENGINEERS DRAWINGS FOR CONNECTION OR FREEZE PROOF YARD HYDRANT.
 6. ALL EQUIPMENT SHALL BE SINGLE PHASE ELECTRIC, TO BE COORDINATED WITH MANUFACTURE AND ELECTRICAL CONTRACTOR.
 7. STATIONARY COMPACTOR TO BE RJ-225 ON SITE COMPACTOR BY MARATHON EQUIPMENT CO.
 8. CONTAINER TO BE RJ-40 OCVL ROLL-OFF OCTAGON COMPACTOR CONTAINER BY MARATHON EQUIPMENT CO.

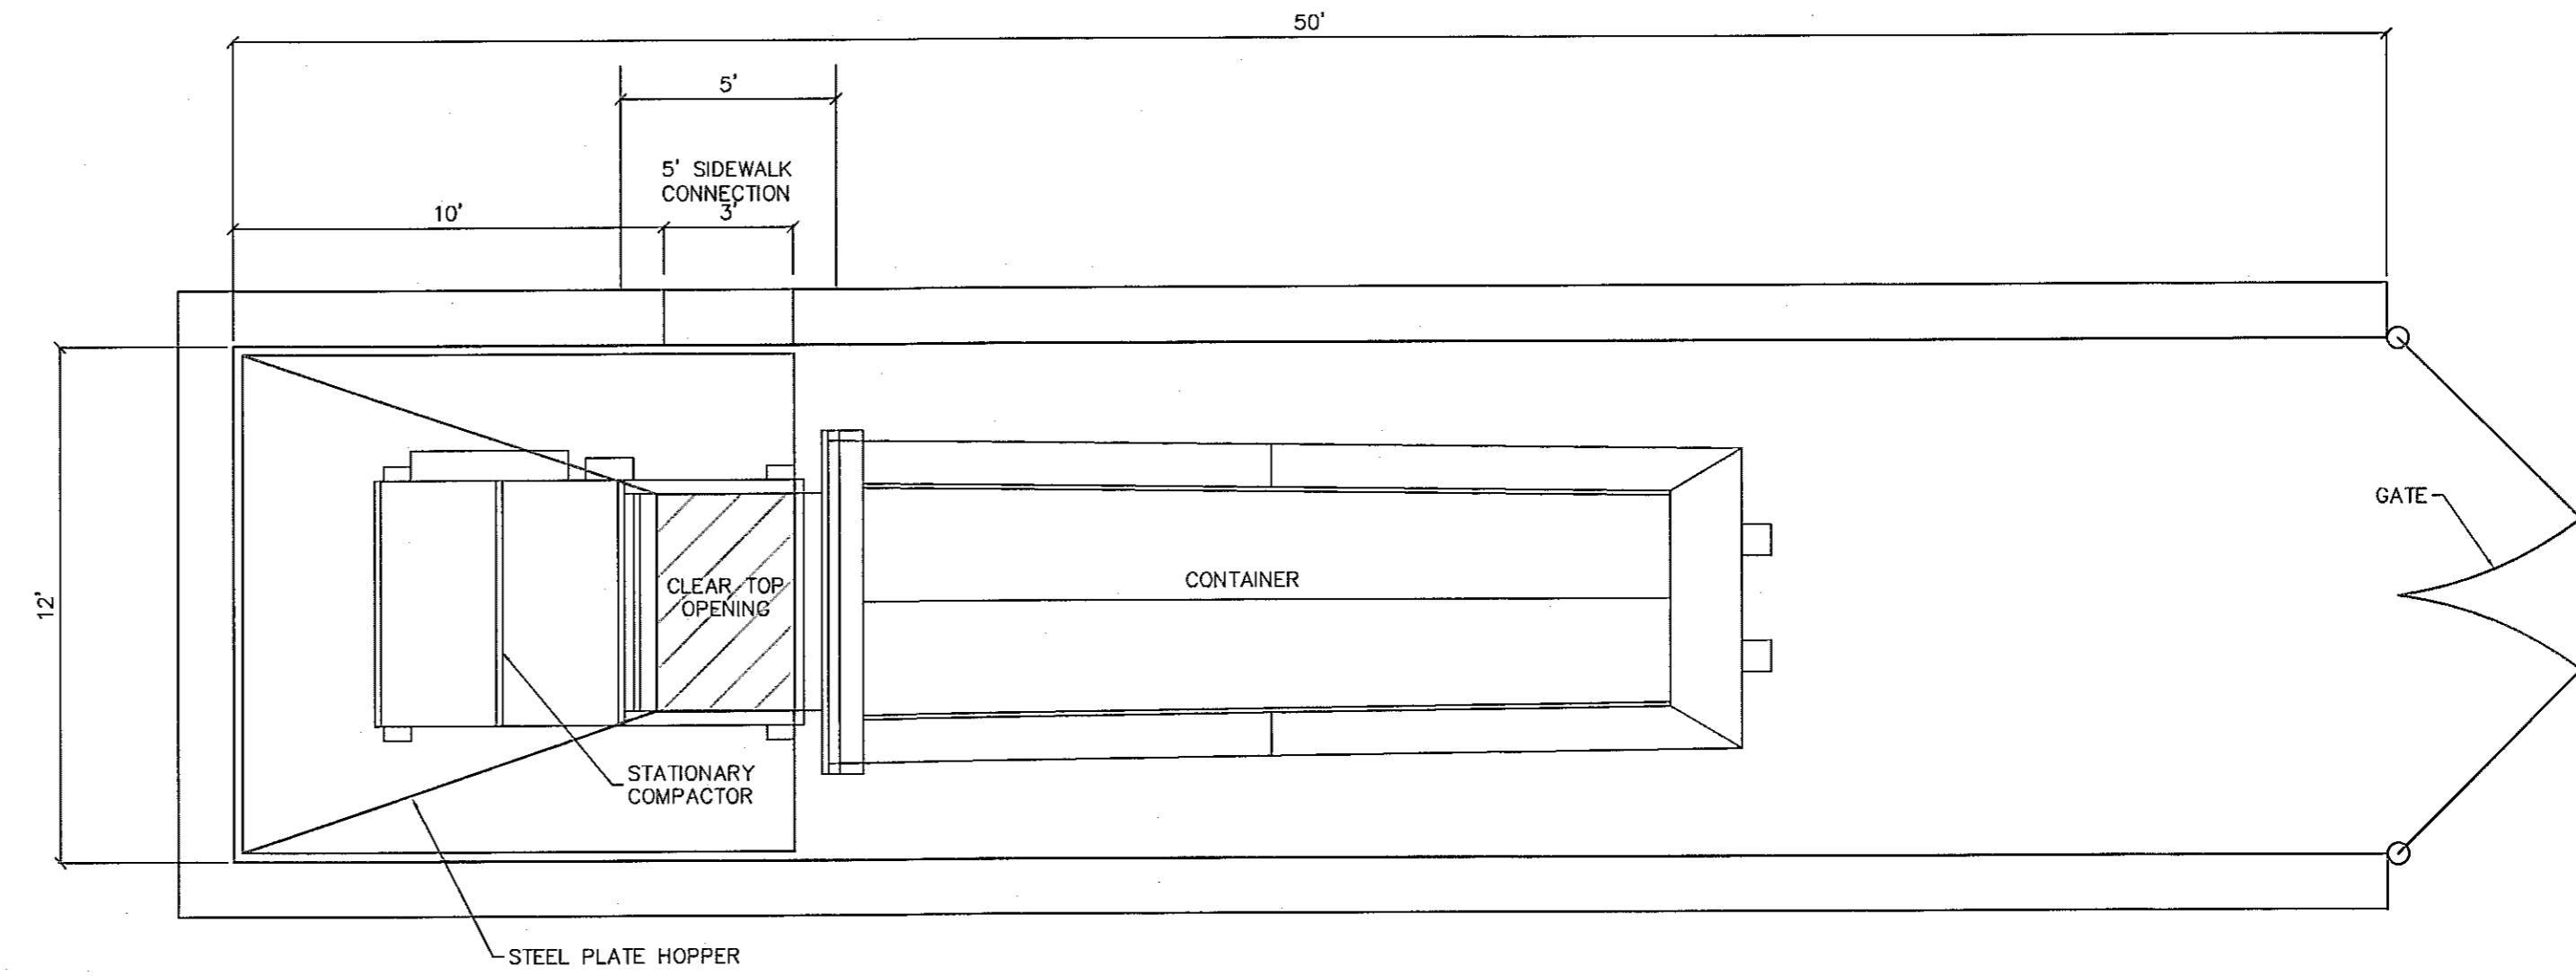

PLAN VIEW

3 TRASH COMPACTOR DETAILS (NOT TO SCALE)


NOTE:
SEE ARCHITECTURAL
DRAWINGS FOR TRASH
ENCLOSURE ELEVATIONS
AND DETAILS

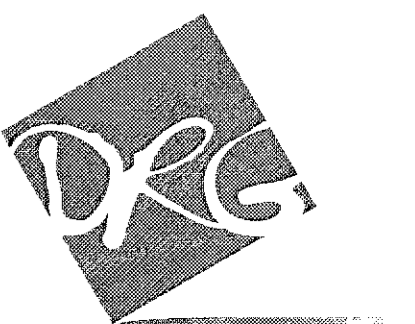

design resource group

- landscape architecture
- civil engineering
- urban design
- land planning
- traffic engineering
- transportation planning


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CONSTRUCTION DOCUMENTS

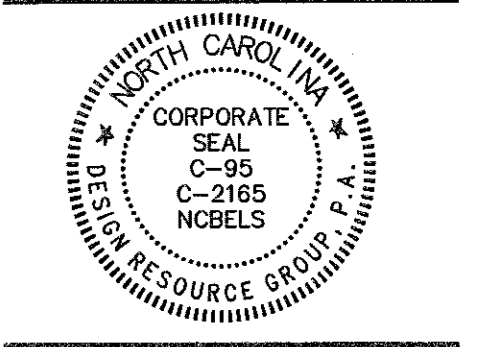

SCALE: NTS

PROJECT #: 217-028
DRAWN BY: JL
CHECKED BY: BG

TRASH COMPACTOR
AND RECYCLING
AREA DETAILS

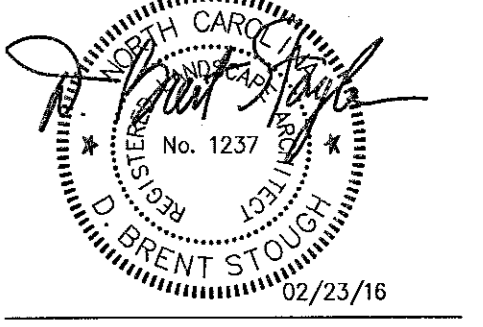FEBRUARY 23, 2016

REVISIONS:

15-SP-013
HTE #: 15-0993
Approved by the Town of Cary
Development Review Committee
Planner: *Killed* Date: *1 Apr 2016*