




PAVEMENT DESIGN
2" 1-2
8" A.B.C.

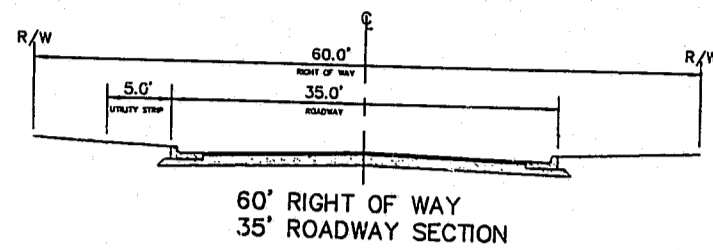

STANDARD STREET SECTIONS

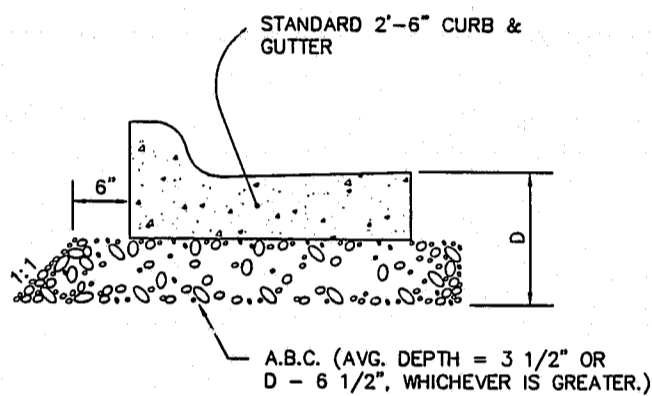

A.B.C. UNDER 2'-6" CURB & GUTTER

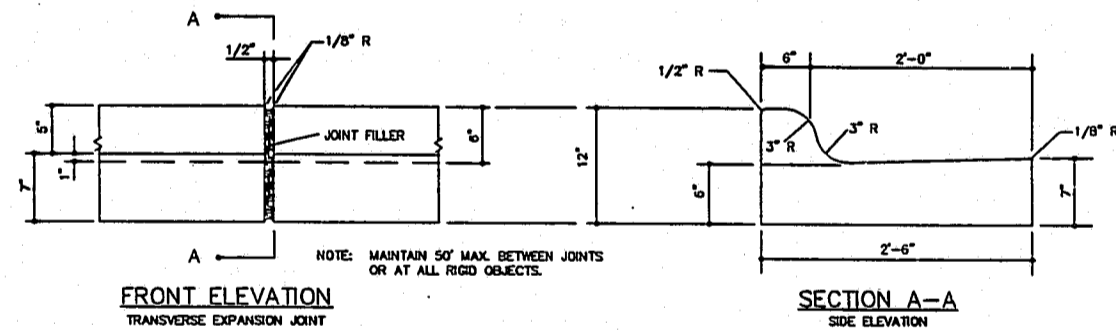


COMBINATION CURB AND GUTTER

SECTION A-A
SIDE ELEVATION

- NOTES:
1. CONCRETE SHALL BE 3,000 P.S.I.
 2. CONTRACTION JOINTS SHALL BE SPACED AT 10' INTERVALS. (A 10' SPACING WILL BE ALLOWED WHEN A MACHINE IS USED.)
 3. FINISH ALL CONCRETE WITH CURING COMPOUND


STANDARD CONCRETE CURB AND GUTTER

NTS

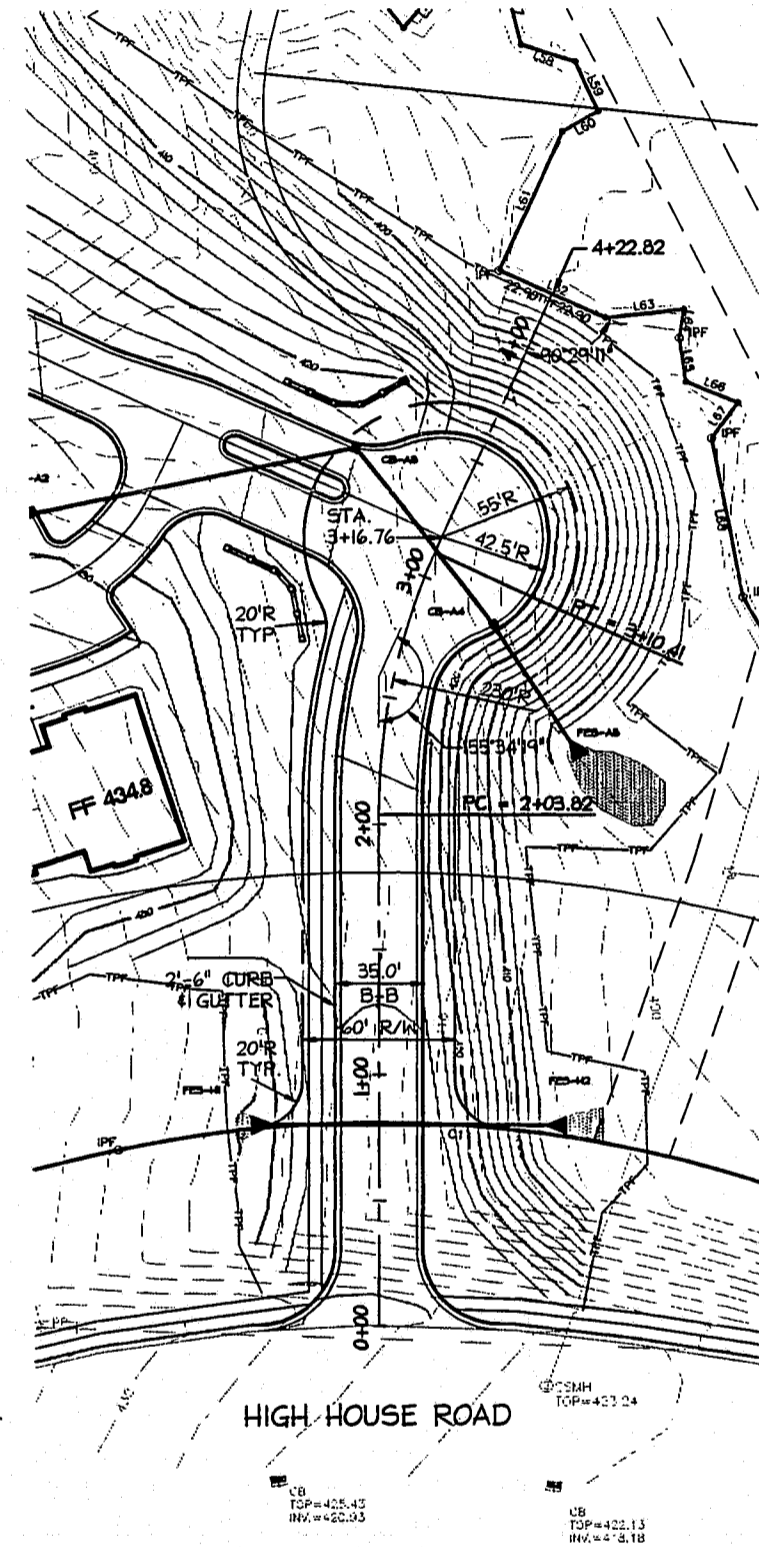


CONNECTOR ROAD - PLAN

SCALE: 1"=50'

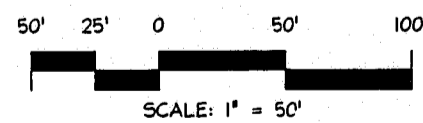


SCALE: 1" = 50'

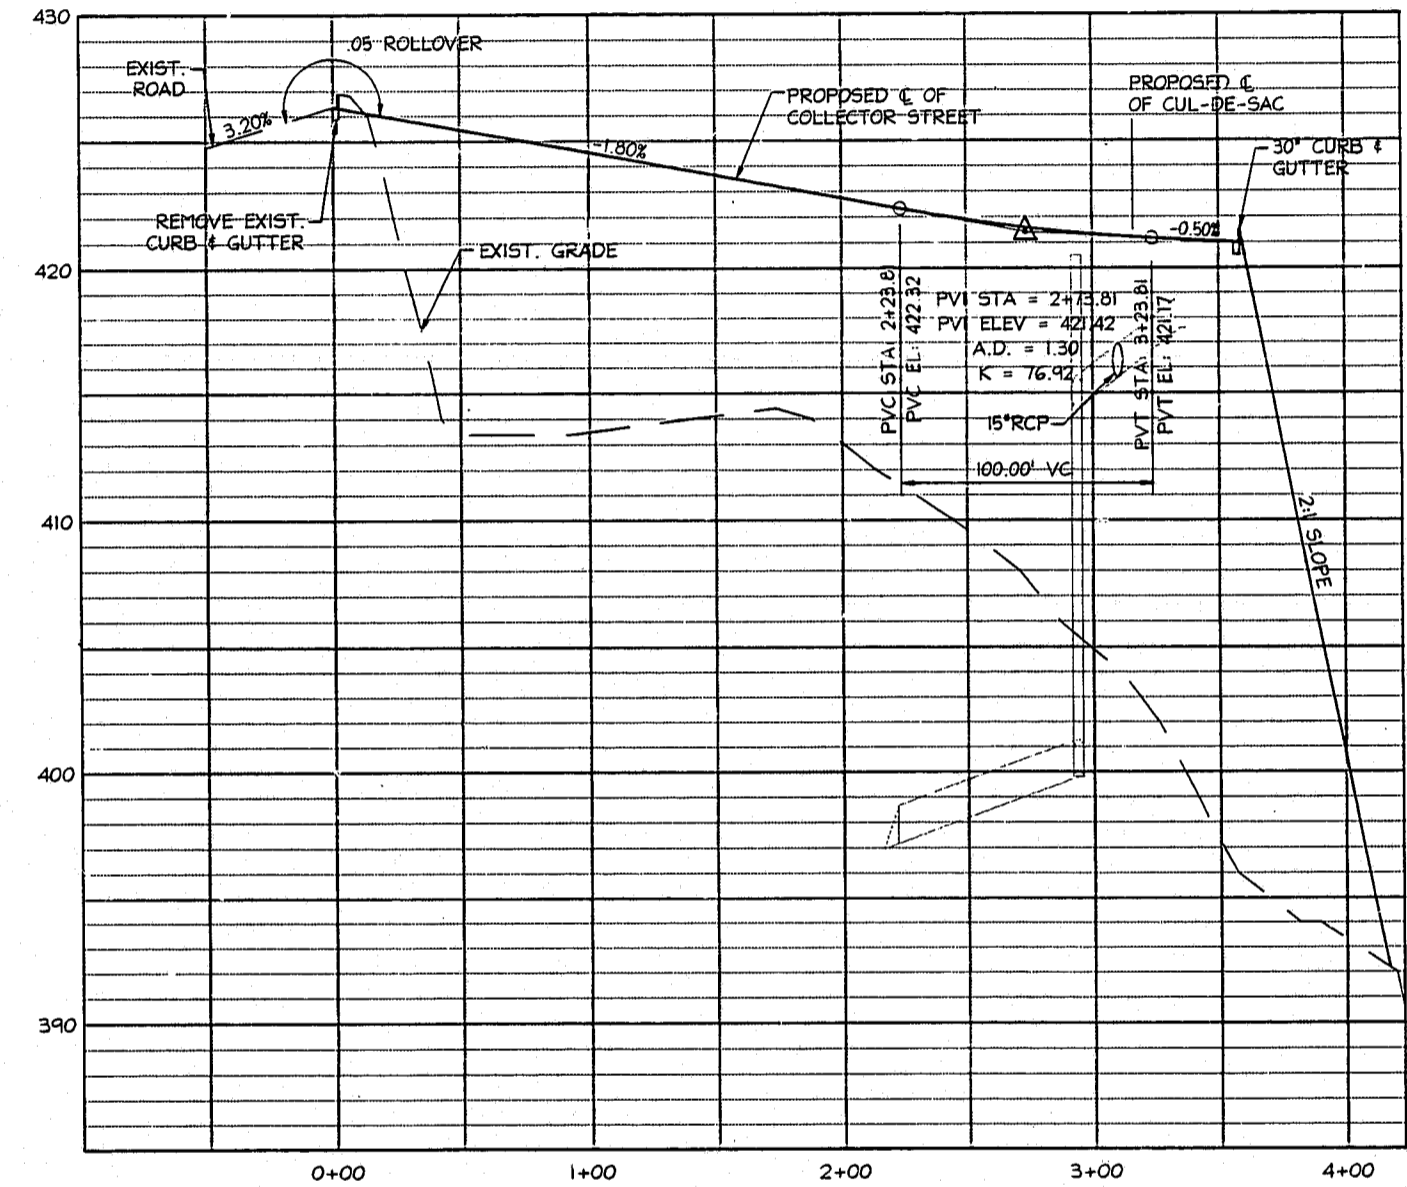

CONNECTOR ROAD - PROFILE

SCALE: 1"=50' (HORIZ.)
SCALE: 1"=5' (VERT.)

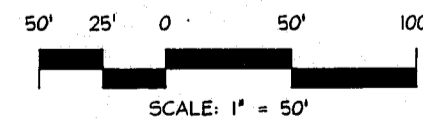

SCALE: 1" = 50'

CONSTRUCTION DRAWINGS

REV. NO.	DESCRIPTIONS	DATE

DESIGNED	JRF
DRAWN	JRF
CHECKED	ADS
PROJ. ENGR.	JCH

MCKIM & CREED
ENGINEERS • PLANNERS • SURVEYORS
WILMINGTON, NORTH CAROLINA RALEIGH, NORTH CAROLINA
SMITHFIELD, NORTH CAROLINA

WATERFORD FOREST APARTMENTS
CARY, N.C.

CONNECTOR ROAD
PLAN AND PROFILE

DATE: 24 FEB 95
MCE PROJ. #0976-0007
DWG FILE #56&CONNECT

SCALE	HORIZONTAL:
1"=50'	1"=50'
VERTICAL:	1"=5'

SHEET NO.	19
OF 27	

S:\0976\0007\A.C.D - DWG\56&CONNECT 11-25-94 1:40:14 pm EST